

SBOK

BL

NORTH

Ground Storey Plan

1:100

ERF 1571 - COVERAGE			
SITE	ERF 1571	Area 602.63m ²	
0			
Coverage Site : Permissable m ²		50% 301m²	
Actual Coverage m²		27% 157m²	
Height Restriction	measured from base leve	l 8m	
Building Lines:			
Street		4m	
Side Rear		2m 2m	

YDrainage to

Site Boundary


HARTEBEES STREET


REFER TO CIVIL ENGINEERS DRAWINGS AND

LEVELS - ALL LEVELS TO BE CONFIRMED BY CIVIL ENGINEER PRIOR TO ANY WORK BEING DONE

Municipal connection

PLAN LEGEND	
New Masonry walls - 190mm Cement Block walls - Plaster and paint	
New Fibre Cement walls - 114x38 Timber frame wall with Nutec 10mm High desity board external/12mm Rhinoboard drywall internal	
New Concrete - According to engineer's specifications	
New timber	
New Steel	
New Concrete	-, 4

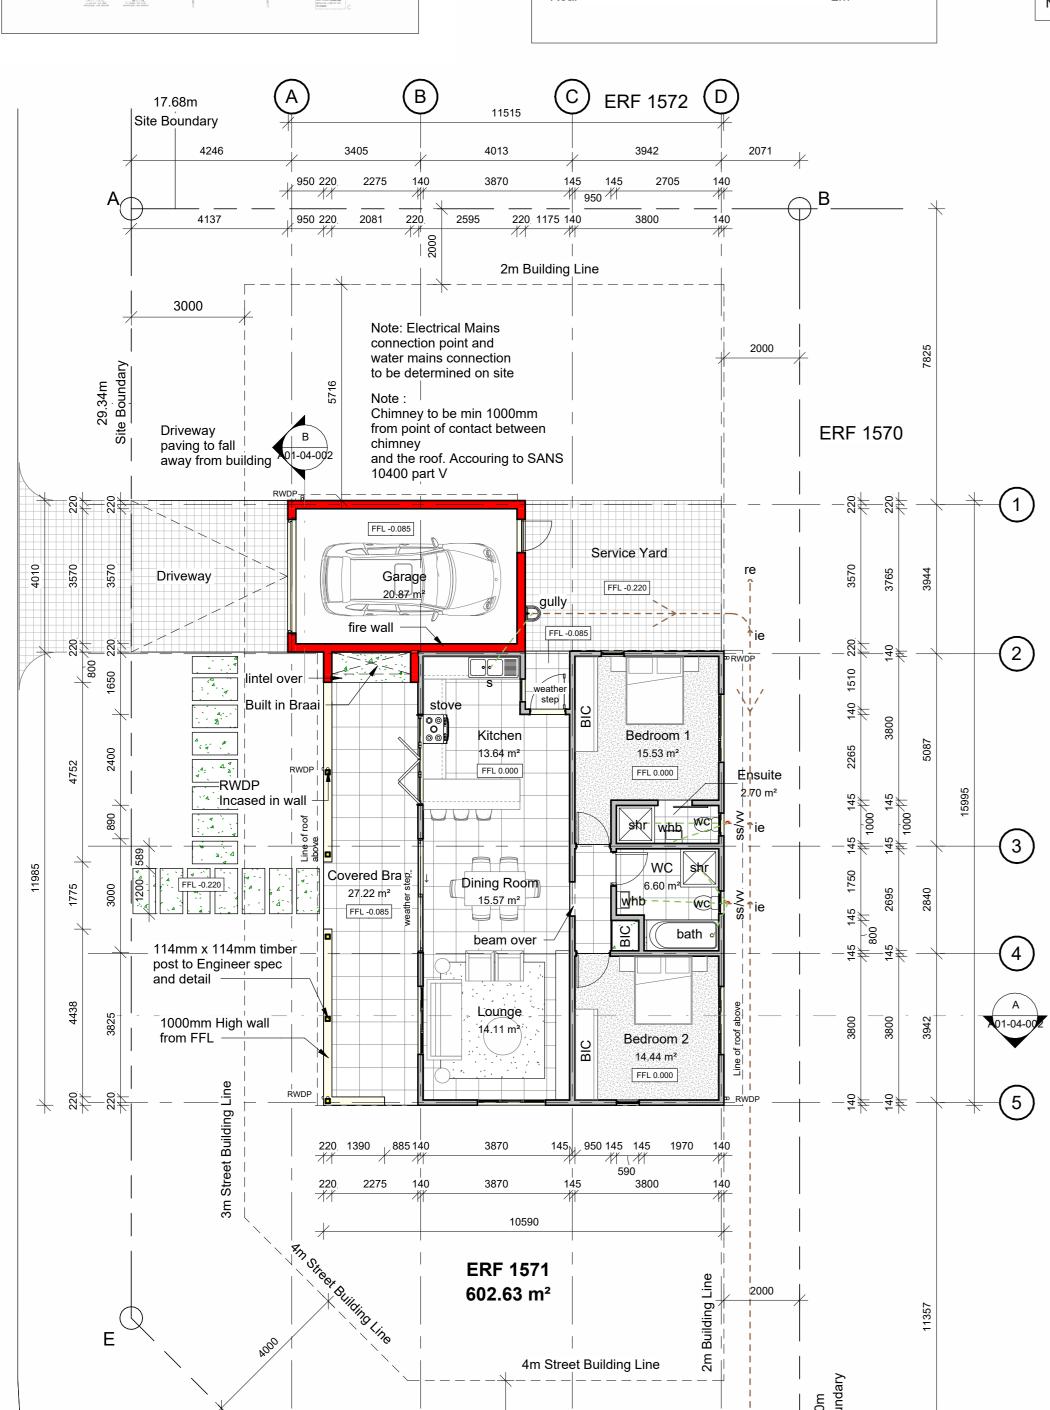

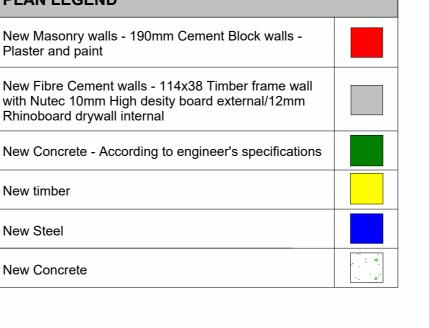

DRAINAGE LEGEND	
110Ø uPVC SP	
50Ø uPVC WP	
110Ø uPVC SS	
uPVC Drainage to have minimur	n invert level of

uPVC Drainage to have minimum invert level of 450mm and maximum fall of 1:40. RE's at ends and at maximum 25m spaces. IE's at junctions. SS 2WVV's to be in ducts with access at joints

ROOF 1 - Main Roof Construction: Global Roofing Solutions 700mm cover Klip-Lok 700™ profile roll-formed in continuous lengths @ 25deg fixed to 76 x 52mm Timber purlins @ 1100mm c/c fixed to Engineerd roof trusses @ 1100mm c/c

Insulation as per SANS XA report

Chimney


ROOF 3


ROOF 2 - Covered Braai Roof Construction: Global Roofing Solutions 700mm cover Klip-Lok 700™ profile roll-formed in continuous lengths @ 2deg fixed to 76 x 52mm
Timber purlins @ 1100mm c/c fixed to Engineerd roof trusses @ 1100mm c/c

ROOF 3 - Garage Roof Construction:
Global Roofing Solutions 700mm cover Klip-Lok 700™ profile roll-formed in continuous lengths @ 2deg fixed to 76 x 52mm Timber purlins @ 1100mm c/c fixed to Engineerd roof trusses @ 1100mm c/c

6065

walls below

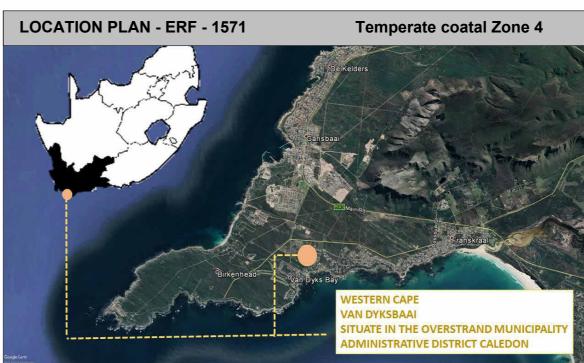

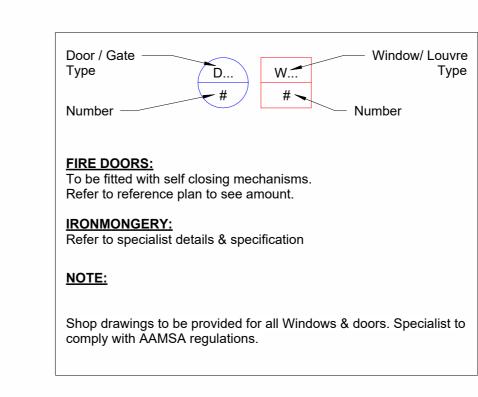


RWDP NOTE: • Gutter and down pipes - all sizes and numbers of down pipes & gutters to specialist details Rainwater down pipes to surface discharge into new stormwater system • Rainwater down pipe spreader to discharge onto Roof 2 and to be taken down in rwdp

Adequate waterproofing

and flasing to specialist

ROOF 1

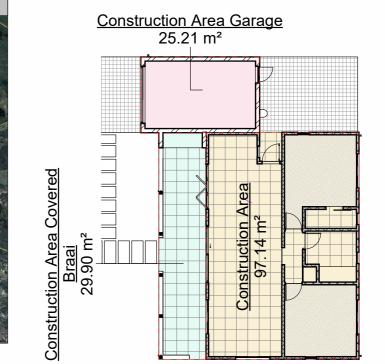

GCA Legend


Construction Area Construction Area

Covered Braai **Construction Area** Garage


GCA Area Plan

1:200

Gross Constructable	Area
Name	Area
Construction Area	97 m²
Construction Area Covered Braai	30 m²
onstruction Area Carage	25 m ²

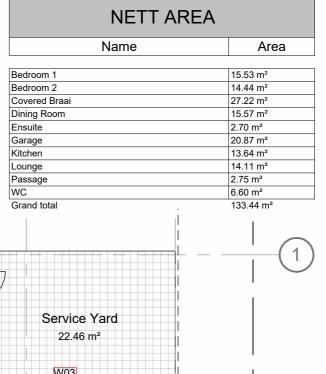

Garage 20.87 m² 27.22 m² Bedroom 1 15.53 m² 13.64 m² Dining Room 27.22 m² Bedroom 2 14.44 m²

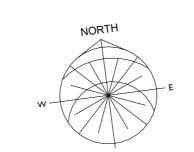


Roof Plan

1:200

ERF 1571 602.63 m²

(C)

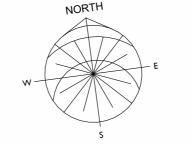

Window & Door Ref Plan

1:100

CONSTRUCTION DISCLAIMER The Architectural Professional will not be held liable if these drawings are implemented prior to Municipal Approval.

LEGAL REQUIREMENTS

DIMENSIONS, DESCRIPTIONS & QUANTITIES ON THESE DRAWINGS TO BE VERIFIED ON SITE BEFORE ORDERING MATERIAL OR ALL WORK TO BE CARRIED OUT IN STRICT ACCORDANCE WITH THE NATIONAL BUILDING REGULATIONS & STANDARDS ACT (ACT 103 OF 1977 & SANS 10400)

ALL TIMBER SIZES & GRADES TO BE VERIFIED & APPROVED BY SUPPLIER'S ENGINEER.
ALL TRUSSES TO BE IN ACCORDANCE WITH SUPPLIER'S /
ENGINEER'S DESIGN & APPROVAL BY CLIENT.
ALL MATERIALS TO BE BUILT IN / APPLIED STRICTLY IN ACCORDANCE WITH MANUFACTURER'S SPECIFICATIONS AND INSTRUCTIONS. ALL LOCAL AUTHORITY, UTILITY SERVICE PROVIDER REQUIREMENTS TO BE ESTABLISHED IN ADVANCE AND ADHERED TO.

ALL BOUNDARY PEGS TO BE LOCATED, AND MARKED, BEFORE

NO DIMENSIONS TO BE SCALED FROM THESE DRAWINGS.

WORK IS TAKEN IN HAND. ANY DISCREPANCIES BETWEEN THESE DRAWINGS & LEGISLATION, LOCAL AUTHORITY, UTILITY SERVICE PROVIDER & GOOD CONSTRUCTION PRACTICE TO BE REFERRED TO THE ARCHITECT BEFORE CONSTRUCTION COMMENCES. ANY ASPECT DEEMED TO BE UNCLEAR TO BE REFERRED TO THE ARCHITECT FOR CLARITY. THESE DRAWINGS DO NOT CONSTITUTE A COMPREHENSIVE SPECIFICATION FOR THE WORKS.

REVISIONS

=					
	No.	Description	Date	Ву	To
	Α	Municipal Plans	2021/08/01	РВ	Mun

Zoning classification: Residential Zone 1: Single Occupation classification:

Developer/Development:

STAGE 4.1: MUNICIPAL SUBMISSION

THIS DRAWING TO BE STAMPED BY BPAS FOR PENDING APPROVAL or CONSTRUCTION.
BPAS CAN NOT BE HELD LIABLE, RESPONSIBLE OR ACCOUNTABLE FOR ANY
UNAUTHORIZED DRAWINGS USED FOR CONSTRUCTION. THE CONTRACTOR AND/OR
EMPLOYER TO ENSURE THAT ALL DRAWINGS ARE STAMPED.

Client:

Client Represent.:	
Date :	
Client signature:	

Design Architecture:

E. de Jager Professional: SACAP no.: PAD 24743947 Signature:





New Dwelling House on Corner of Hartebees and Steenbok St, Erf 1571 Van Dykbaai.

Drawing: Site Plan / Roof layout

DATE 2021/08/01 DRAWN PB SCALE As indicated

DJ001 A01-04-001

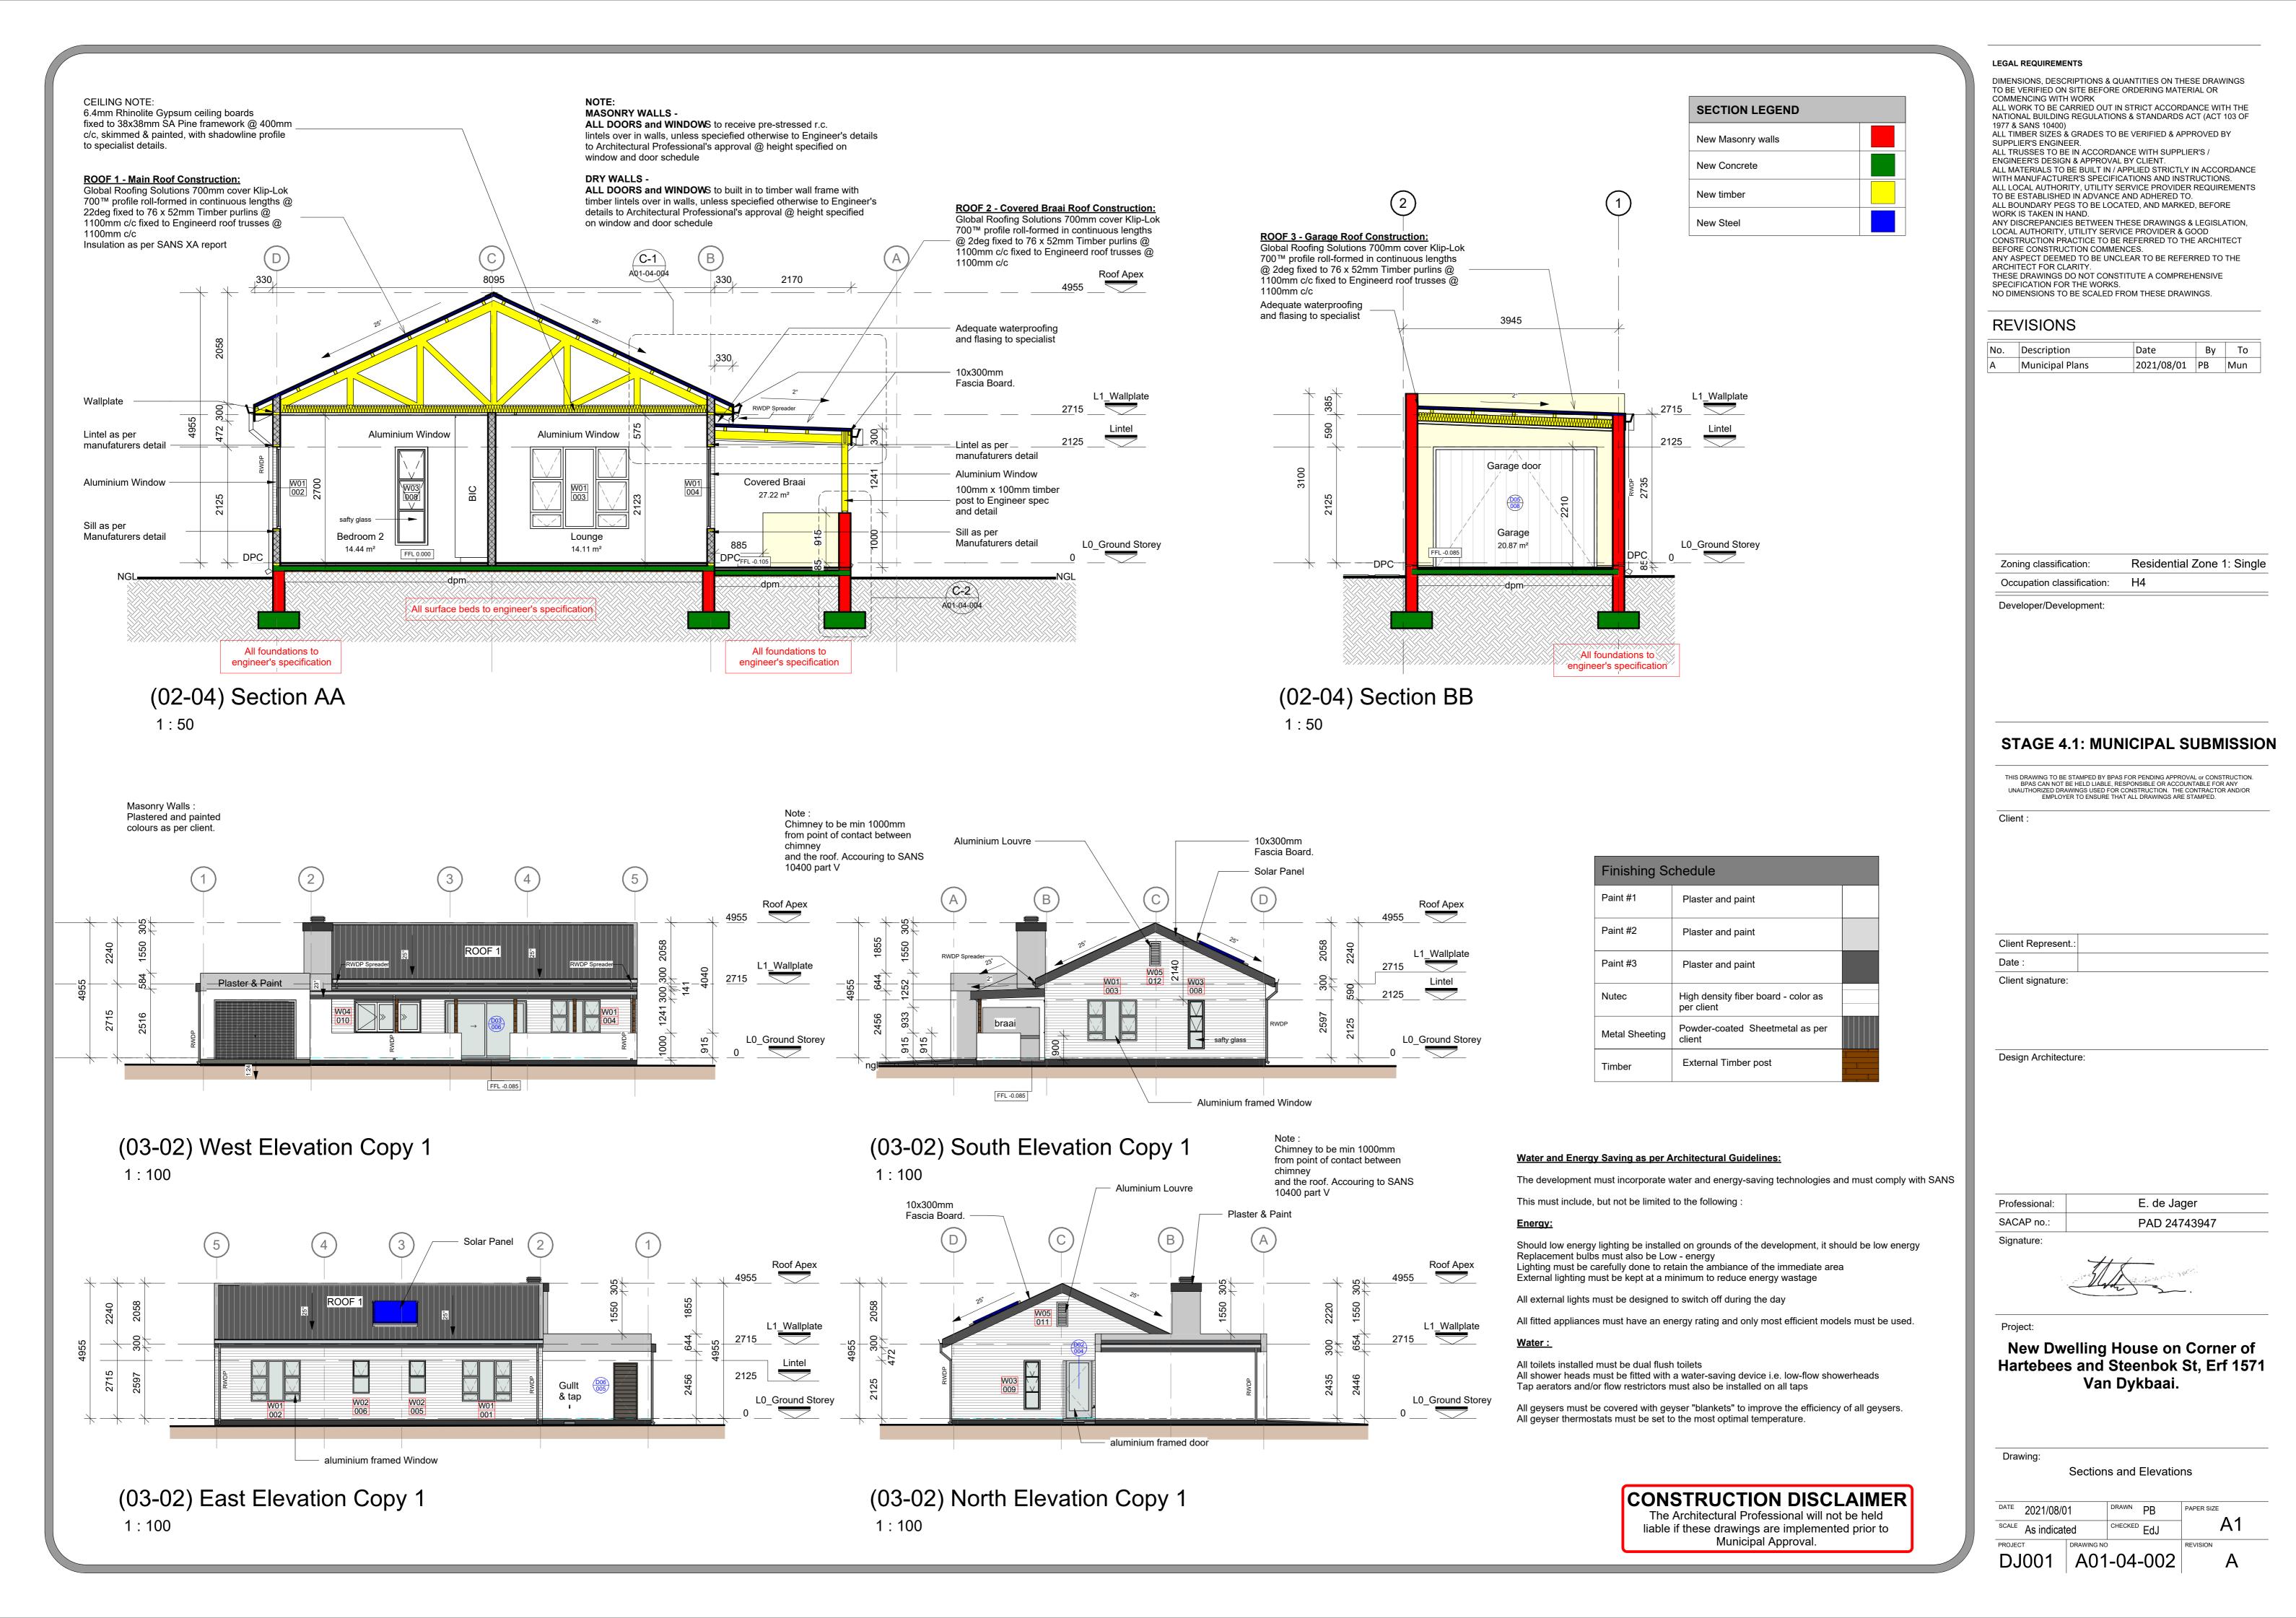

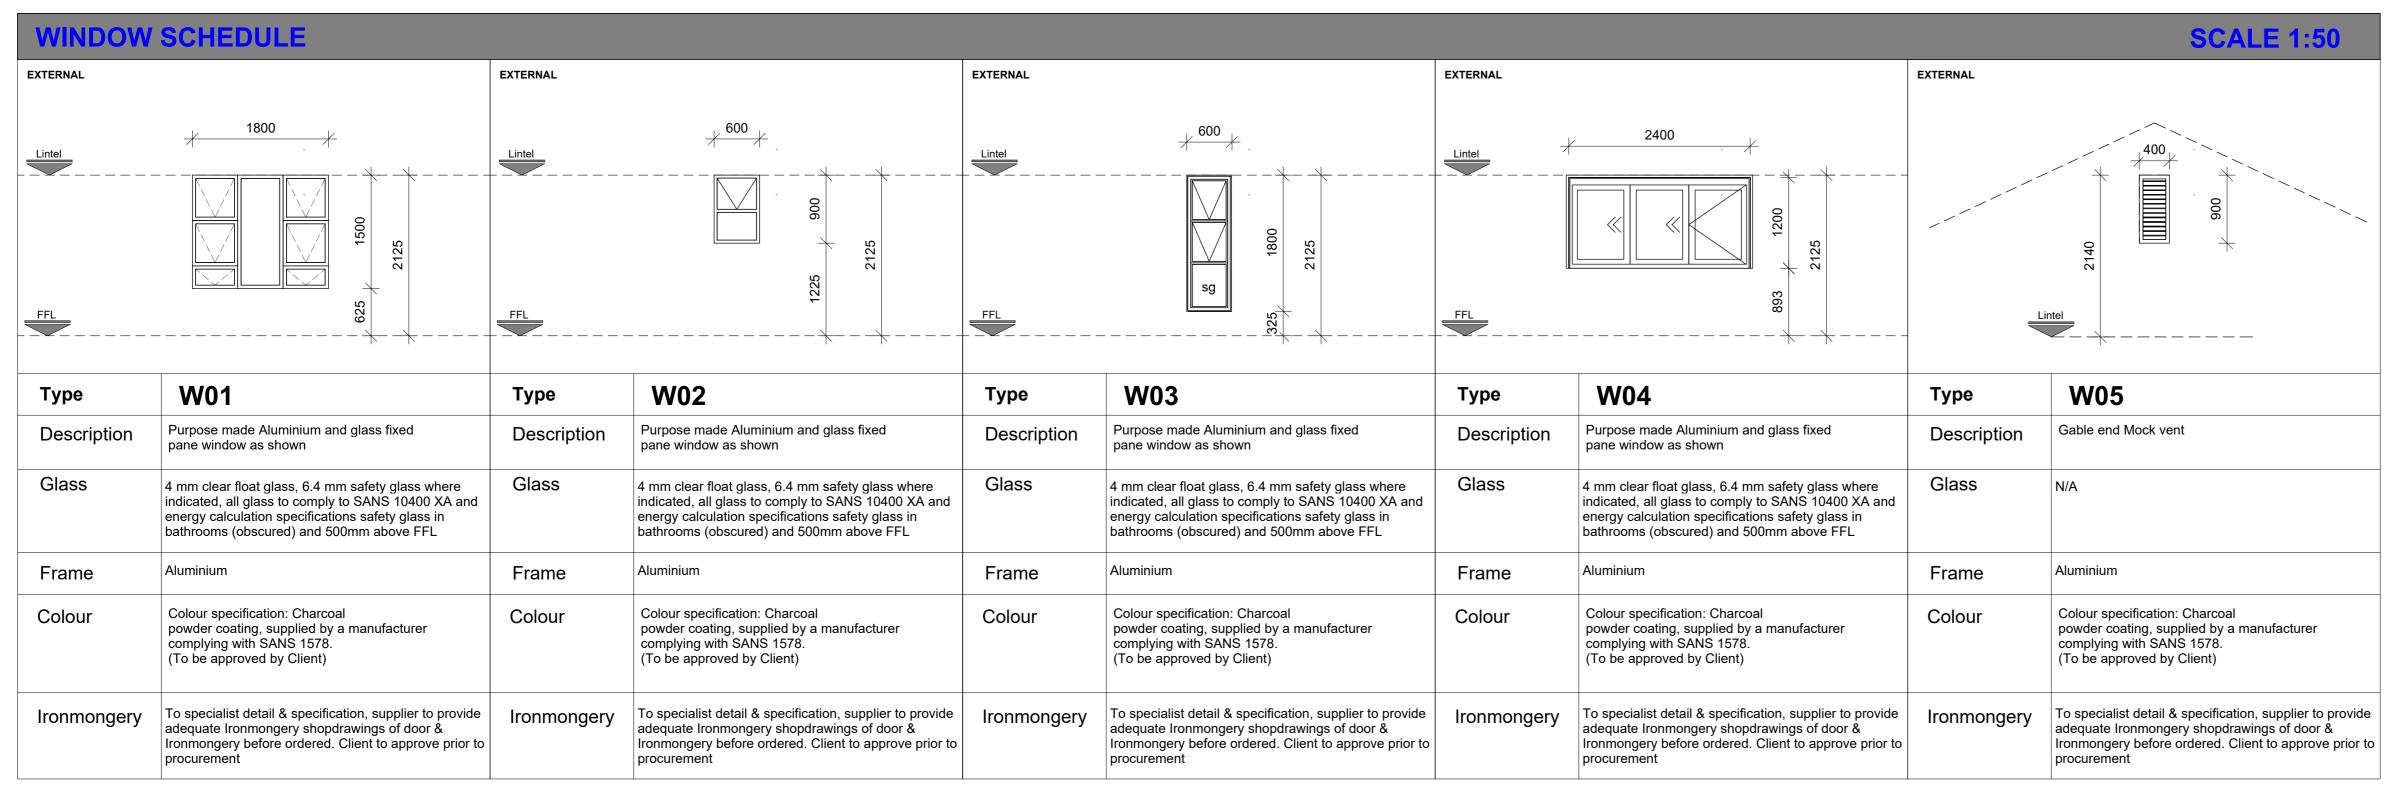

DOOR SO	DOOR SCHEDULE						SCALE 1:50				
XTERNAL		INTERNAL		EXTERNAL		EXTERNAL	Internal Sliding door	EXTERNAL		EXTERNAL	
	900		1016	 	3000		* 900 *	\	3000		* 877 *
	2125			2100	sg		2125	2210	•	2125	
D01		D02		D03		D04		D05		D06	
Description	Internal hollow core door	Description	Aluminium framed door	Description	Aluminium framed Sliding of	door Description	Internal Timber Sliding door	Description	Motorized Garage door	Description	Solid core door Verticaly slatted
Glass	N/A	Glass	4 mm clear float glass, 6.4 mm safety glass where indicated, all glass to comply to SANS 10400 XA	Glass	4 mm clear float glass, 6.4 m glass where indicated, all gla comply to SANS 10400 XA		N/A	Glass	N/A	Glass	N/A
-rame	Timber	Frame	Aluminium	Frame	Aluminium	Frame	Timber	Frame	As per supplier	Frame	Timber
Colour	Colour specification: Charcoal powder coating, supplied by a manufacturer complying with SANS 1578. (To be approved by Client)	Colour	Colour specification: Charcoal powder coating, supplied by a manufacturer complying with SANS 1578. (To be approved by Client)	Colour	Colour specification: Charco powder coating, supplied be manufacturer complying with SANS 1578. (To be approved by Client)	y a th	Painted - As per client	Colour	Colour specification: Charcoal powder coating, supplied by a manufacturer complying with SANS 1578. (To be approved by Client)	Colour	Colour specification: Charcoal powder coating, supplied by a manufacturer complying with SANS 1578. (To be approved by Client)

Туре	Mark
W01	001
W01	001
W01	003
W01	004
W01: 4	
W02	005
W02	006
W02	007
W02: 3	
W03	008
W03	009
W03: 2	
W04	010
W04: 1	
W05	011
W05	012

Type Mark	Mark
	lan.
D01	001
D01	002
D01	003
D01: 3	
D02	004
D02: 1	•
D03	006
D03: 1	'
D04	007
D04: 1	'
D05	008
D05: 1	'
D06	005
D06: 1	

CONSTRUCTION DISCLAIMER

The Architectural Professional will not be held liable if these drawings are implemented prior to Municipal Approval.

LEGAL REQUIREMENTS

DIMENSIONS, DESCRIPTIONS & QUANTITIES ON THESE DRAWINGS
TO BE VERIFIED ON SITE BEFORE ORDERING MATERIAL OR
COMMENCING WITH WORK
ALL WORK TO BE CARRIED OUT IN STRICT ACCORDANCE WITH THE
NATIONAL BUILDING REGULATIONS & STANDARDS ACT (ACT 103 OF

ALL WORK TO BE CARRIED OUT IN STRICT ACCORDANCE WITH THE NATIONAL BUILDING REGULATIONS & STANDARDS ACT (ACT 103 OF 1977 & SANS 10400)
ALL TIMBER SIZES & GRADES TO BE VERIFIED & APPROVED BY

SUPPLIER'S ENGINEER.
ALL TRUSSES TO BE IN ACCORDANCE WITH SUPPLIER'S /
ENGINEER'S DESIGN & APPROVAL BY CLIENT.
ALL MATERIALS TO BE BUILT IN / APPLIED STRICTLY IN ACCORDANCE
WITH MANUFACTURER'S SPECIFICATIONS AND INSTRUCTIONS.
ALL LOCAL AUTHORITY, UTILITY SERVICE PROVIDER REQUIREMENTS
TO BE ESTABLISHED IN ADVANCE AND ADHERED TO.
ALL BOUNDARY PEGS TO BE LOCATED, AND MARKED, BEFORE
WORK IS TAKEN IN HAND.

ANY DISCREPANCIES BETWEEN THESE DRAWINGS & LEGISLATION, LOCAL AUTHORITY, UTILITY SERVICE PROVIDER & GOOD CONSTRUCTION PRACTICE TO BE REFERRED TO THE ARCHITECT BEFORE CONSTRUCTION COMMENCES.

ANY ASPECT DEEMED TO BE UNCLEAR TO BE REFERRED TO THE ARCHITECT FOR CLARITY.

THESE DRAWINGS DO NOT CONSTITUTE A COMPREHENSIVE SPECIFICATION FOR THE WORKS.

NO DIMENSIONS TO BE SCALED FROM THESE DRAWINGS.

REVISIONS

No.	Description	Date	Ву	То
Α	Municipal Plans	2021/08/01	РВ	Mun

Zoning classification: Residential Zone 1: Single
Occupation classification: H4

Developer/Development:

STAGE 4.1: MUNICIPAL SUBMISSION

THIS DRAWING TO BE STAMPED BY BPAS FOR PENDING APPROVAL or CONSTRUCTION.

BPAS CAN NOT BE HELD LIABLE, RESPONSIBLE OR ACCOUNTABLE FOR ANY
UNAUTHORIZED DRAWINGS USED FOR CONSTRUCTION. THE CONTRACTOR AND/OR
EMPLOYER TO ENSURE THAT ALL DRAWINGS ARE STAMPED.

Client :

Client Represent.:

Date :

Client signature:

Design Architecture:

Professional: E. de Jager
SACAP no.: PAD 24743947

Signature:

The state of the s

Project:

New Dwelling House on Corner of Hartebees and Steenbok St, Erf 1571 Van Dykbaai.

Drawing:

Window and Door Schedule


 DATE
 2021/08/01
 DRAWN
 PB
 PAPER SIZE

 SCALE
 1:50
 CHECKED
 EdJ
 A1

 PROJECT
 DRAWING NO
 REVISION


D I001 A01-04-003

Α

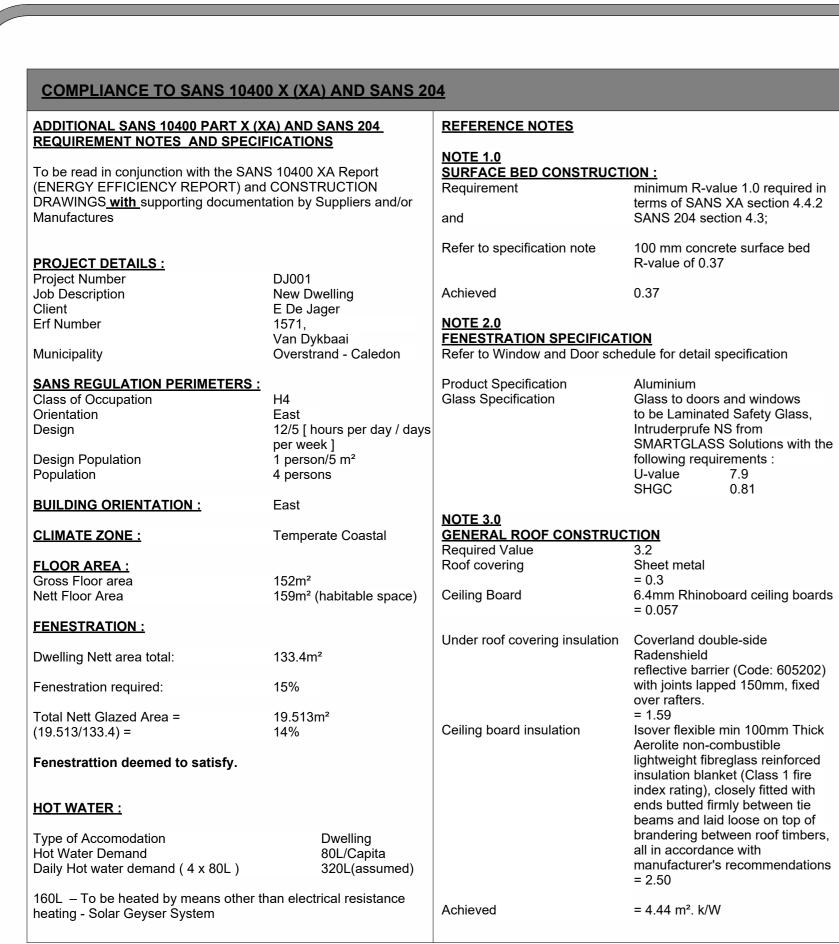


	DISTRIBUTION BOARD
E	ELECTRICAL PREPAID METER
	CEILING LIGHT POINT
	FLUORESCENT TUBE POINT
	WALL LIGHT @ 2200mm AFFL
	PENDENT LIGHTS
<u> </u>	LIGHT SWITCH @ 1100mm AFFL
4	DOUBLE PLUG POINT @ 1050mm AFFL
	DOUBLE PLUG POINT @ 300mm AFFL, where with a T.V. point @ appropriate height
	SINGLE PLUG POINT @ 300mm AFFL, where with a T.V. point @ appropriate height
ST	STOVE CONNECTION POINT
\rightarrow	ISOLATOR SWITCH @ 1050mm AFFL
D-	STOVE EXTRACTOR CANOPY POINT @ 2200mm AFFL
TV	TELEVISION AERIAL POINT @ 300mm AFFL
	TELEPHONE
	GARAGE DOOR MOTOR & PLUG
	DATA POINT/ ETHERNET PORT

ELECTRICAL LEGEND

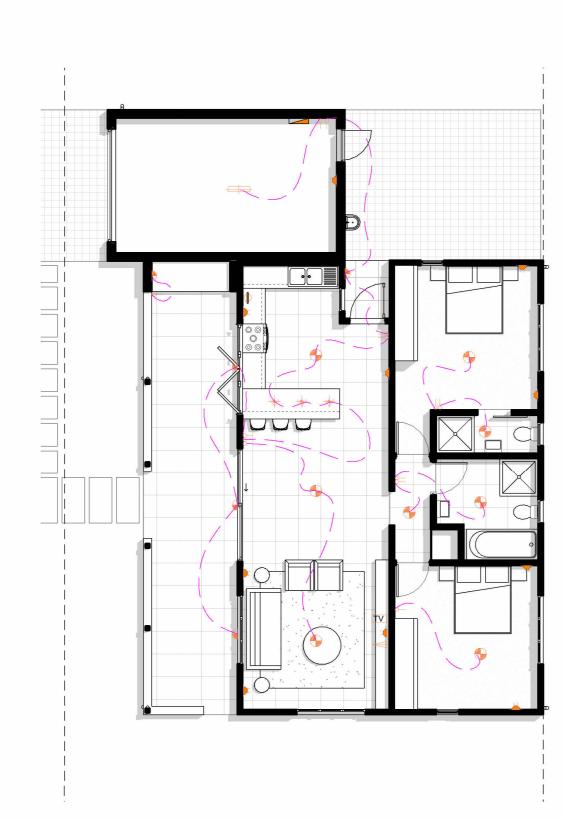


Electrical Plan

1:100

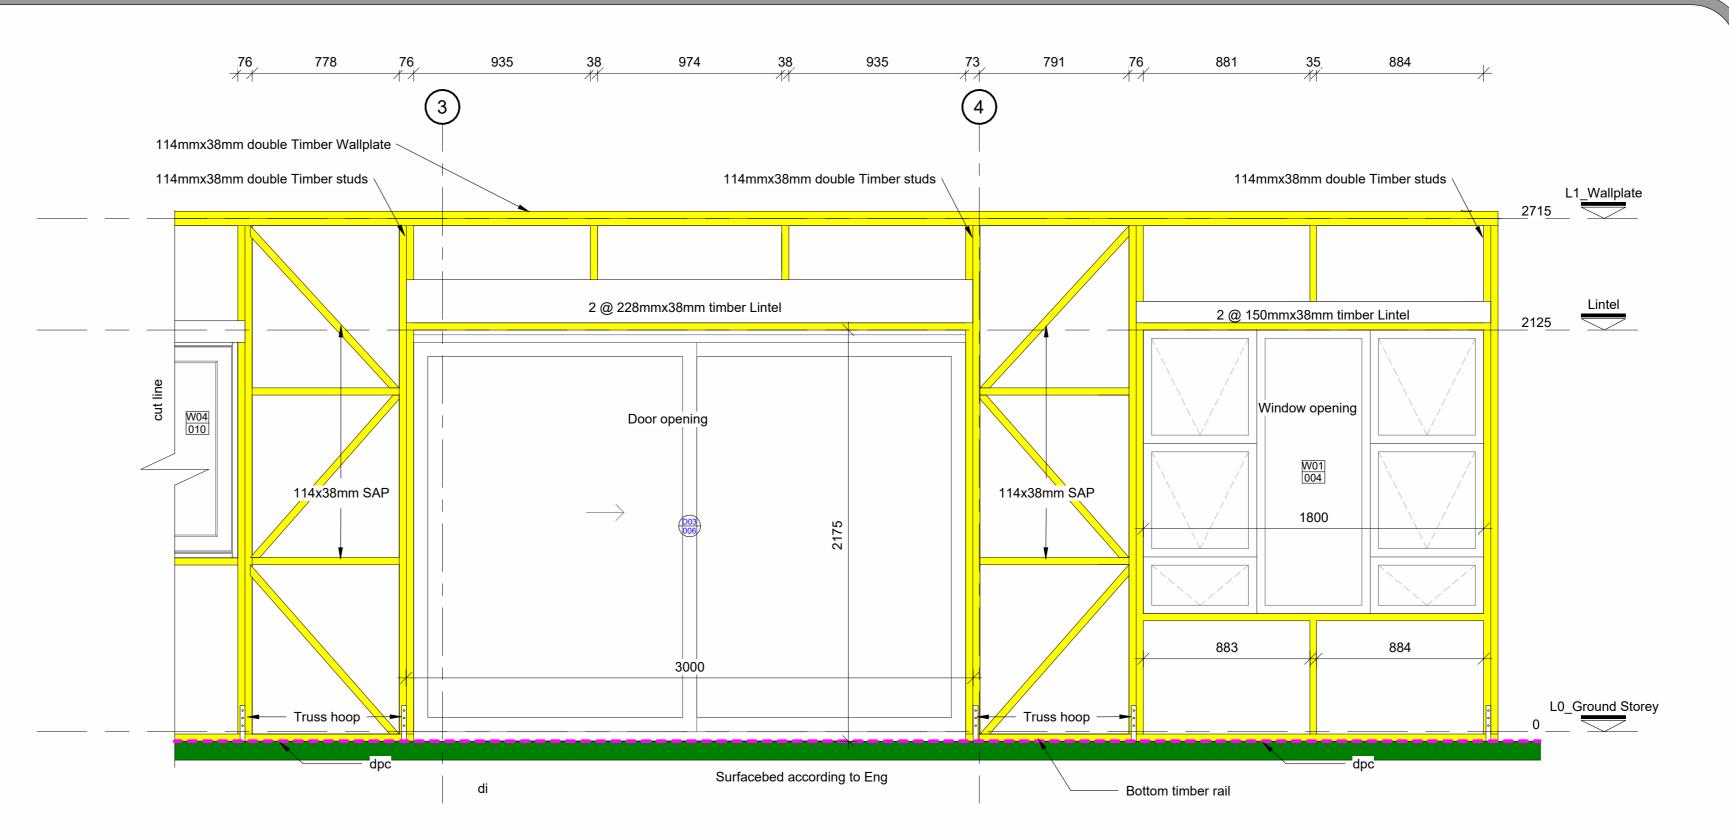

Window and door Wall Structure Detail

1:20

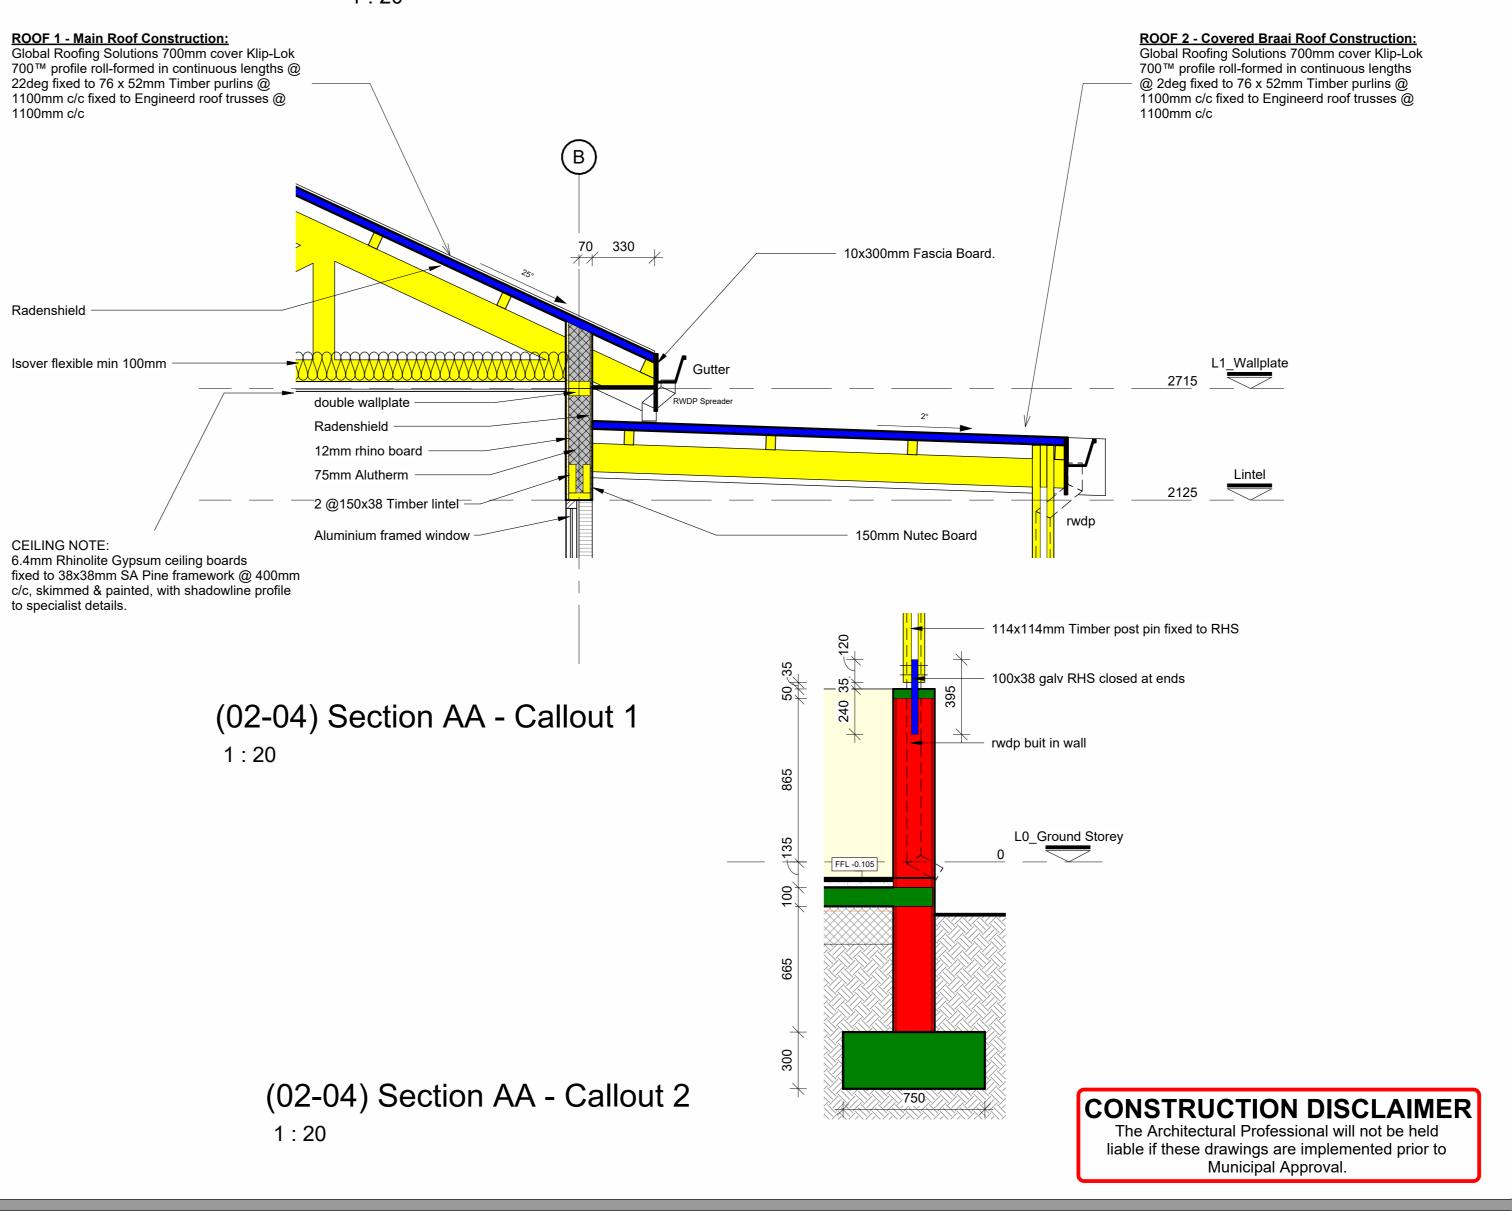

LEGAL REQUIREMENTS

DIMENSIONS, DESCRIPTIONS & QUANTITIES ON THESE DRAWINGS TO BE VERIFIED ON SITE BEFORE ORDERING MATERIAL OR COMMENCING WITH WORK

ALL WORK TO BE CARRIED OUT IN STRICT ACCORDANCE WITH THE NATIONAL BUILDING REGULATIONS & STANDARDS ACT (ACT 103 OF 1977 & SANS 10400)
ALL TIMBER SIZES & GRADES TO BE VERIFIED & APPROVED BY

1977 & SANS 10400)
ALL TIMBER SIZES & GRADES TO BE VERIFIED & APPROVED BY
SUPPLIER'S ENGINEER.
ALL TRUSSES TO BE IN ACCORDANCE WITH SUPPLIER'S /
ENGINEER'S DESIGN & APPROVAL BY CLIENT.
ALL MATERIALS TO BE BUILT IN / APPLIED STRICTLY IN ACCORDANCE
WITH MANUFACTURER'S SPECIFICATIONS AND INSTRUCTIONS.

ALL LOCAL AUTHORITY, UTILITY SERVICE PROVIDER REQUIREMENTS

TO BE ESTABLISHED IN ADVANCE AND ADHERED TO.
ALL BOUNDARY PEGS TO BE LOCATED, AND MARKED, BEFORE
WORK IS TAKEN IN HAND.
ANY DISCREPANCIES BETWEEN THESE DRAWINGS & LEGISLATION,
LOCAL AUTHORITY, UTILITY SERVICE PROVIDER & GOOD
CONSTRUCTION PRACTICE TO BE REFERRED TO THE ARCHITECT
BEFORE CONSTRUCTION COMMENCES.

ANY ASPECT DEEMED TO BE UNCLEAR TO BE REFERRED TO THE ARCHITECT FOR CLARITY.

THESE DRAWINGS DO NOT CONSTITUTE A COMPREHENSIVE SPECIFICATION FOR THE WORKS.

NO DIMENSIONS TO BE SCALED FROM THESE DRAWINGS.

REVISIONS

	No.	Description	Date	Ву	То
	Α	Municipal Plans	2021/08/01	РВ	Mun

Zoning classification:	Residential Zone 1: Single
Occupation classification:	H4

Developer/Development:

STAGE 4.1: MUNICIPAL SUBMISSION

THIS DRAWING TO BE STAMPED BY BPAS FOR PENDING APPROVAL or CONSTRUCTION.
BPAS CAN NOT BE HELD LIABLE, RESPONSIBLE OR ACCOUNTABLE FOR ANY
UNAUTHORIZED DRAWINGS USED FOR CONSTRUCTION. THE CONTRACTOR AND/OR
EMPLOYER TO ENSURE THAT ALL DRAWINGS ARE STAMPED.

Client :

Client Represent.:	
Date :	

Client signature:

Design Architecture:

Professional: E. de Jager

SACAP no.:
Signature:

1/1

PAD 24743947

New Dwelling House on Corner of Hartebees and Steenbok St, Erf 1571 Van Dykbaai.

Drawing:

Details & Electrical plan

DATE 2021/08/0		DRAWN	PB	PAPER SIZE
As indicat	ea		EdJ	/ \ I
PROJECT	DRAWING NO)		REVISION
DJ001	A01	-04-	-004	Α